

ARCHITECTURAL GENERAL NOTES

IN THE INTERPRETATION OF THESE DRAWINGS, INDICATED DIMENSIONS SHALL GOVERN AND DISTANCES OR SIZES SHALL NOT BE SCALED FOR CONSTRUCTION PURPOSES.

SHOULD BE REFERRED TO PPSDS BEFORE EXECUTION OF

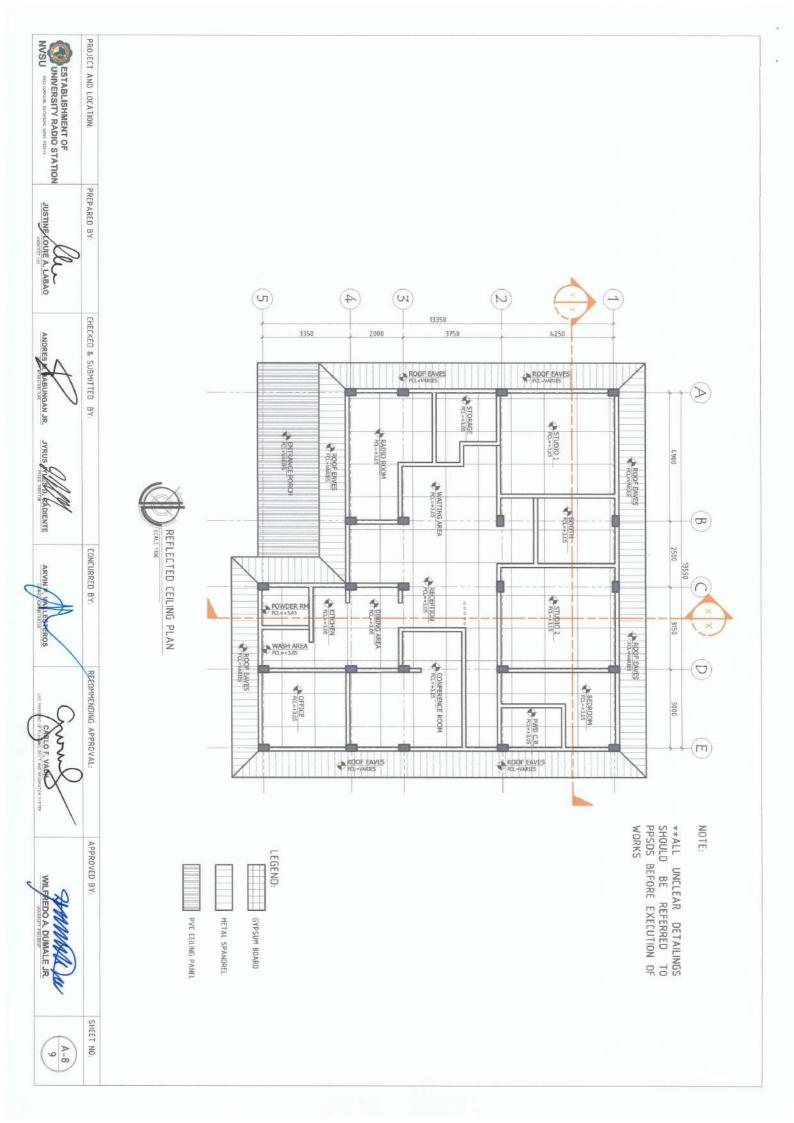
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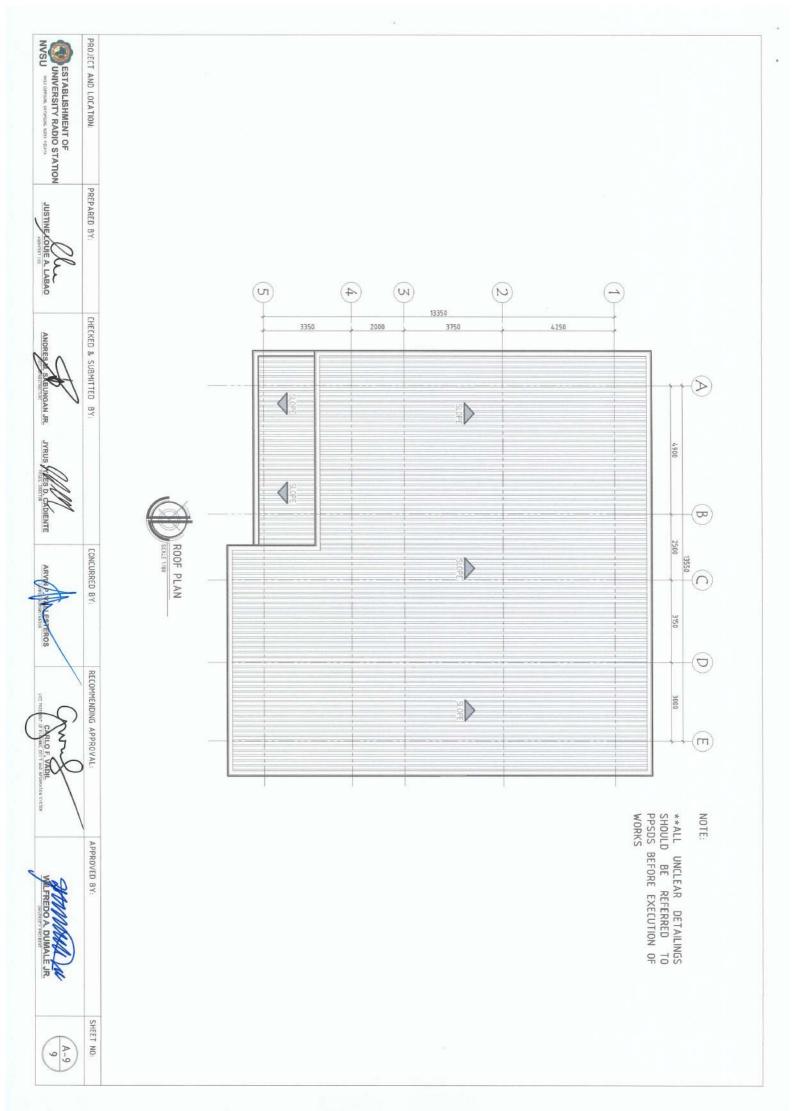
**ALL

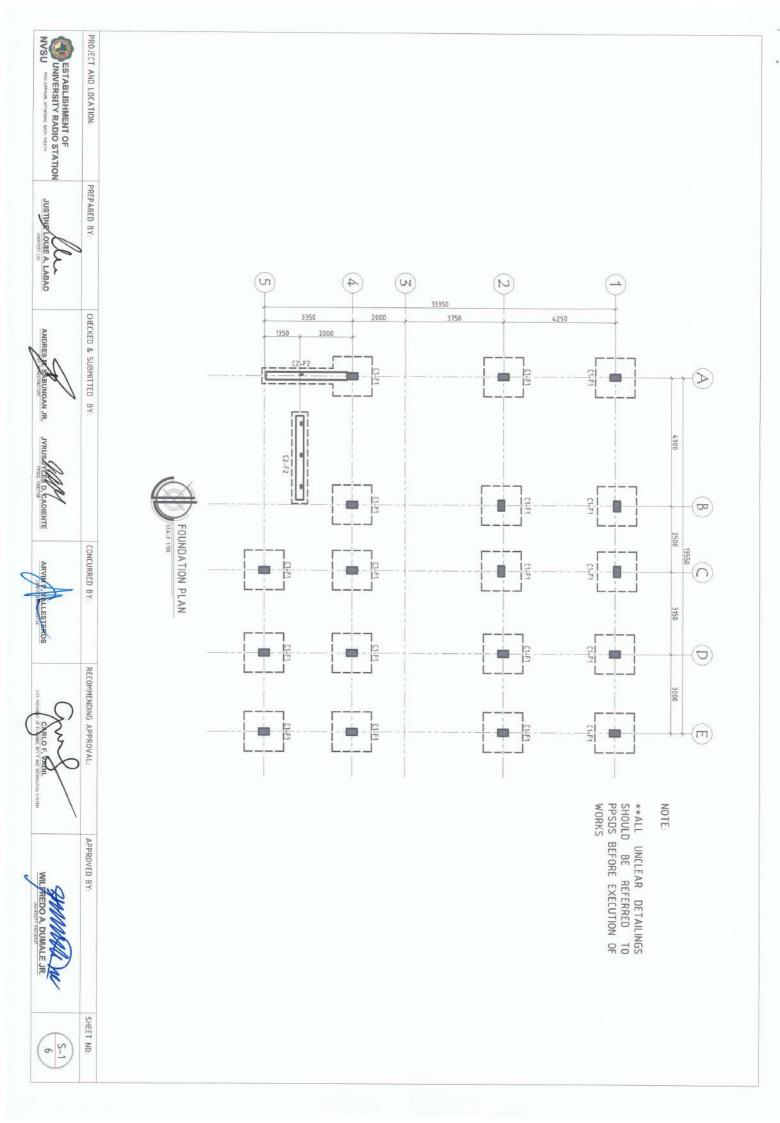
UNCLEAR DETAILINGS

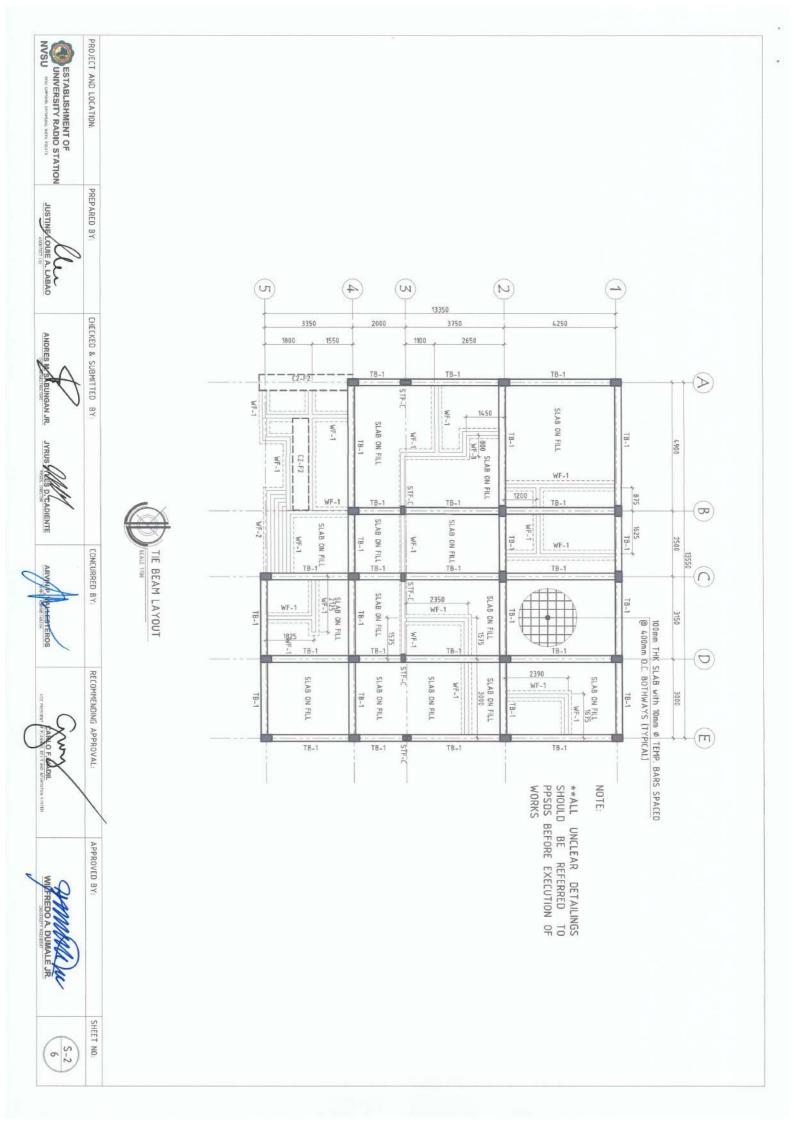
- UNLESS OTHERWISE INDICATED, ALL DIMENSIONS ARE IN MILLIMETERS.
- ALL DRAWINGS SHALL NOTE BE SCALED ONLY WRITTEN DIMENSIONS SHALL BE FOLLOWED.
- ALL DRAWINGS SHALL BE READ IN CONJUNCTION FOR PROPER COORDINATION
- ANY INCONSISTENCY OR DISCREPANCY IS TO BE BROUGHT TO THE ATTENTION OF THE ARCHITECT/ENGINEER BEFORE COMMENCEMENT OF WORKS.
- OPENINGS THRU FLOOR, SLABS, BEAMS AND WALLS AND ALSO BUILDING DIMENSIONS. THECONTRACTOR SHALL COORDINATE WITH THE AR, ME, SE, EE AND OTHER UTILITIES AND EQUIPMENT PLANS FOR THE EXACT SIZE, NUMBER AND LOCATIONS OF ALL SLEEVES OR
- SPECIFICATIONS (LATEST EDITION) IN SO FAR AS THEY DO NOT CONFLICT WITH THE LOCAL BUILDING CODE REQUIREMENTS. ALL REINFORCED CONCRETE SHALLBE DONE IN ACCORDANCE WITH THE ACI-318-89 BUILDING CODE, AND ALL B. STRUCTURAL STEEL WORK SHALL BE DONE IN ACCORDANCE WITH AISC
- ALL SLABS, BEAMS,GIRDERS AND OTHER STRUCTURAL ELEMENTS WHICH ARE NOT INDICATED, DETAILED, 9. DESIGNATED OR INADVERTENTLY OMITTED BUT ARE NECESSARY TO BE PLANS AND SPECIFICATIONS SHALL BE BROUGHT UP DURING PRE-BIDS / MEETINGS / NEGOTIATIONS. IT IS UNDERSTOOD THAT THE CONTRACTOR HAS PROVIDED AND INCLUDED ALL THESE ITEMS IN THEIR BID. COORDINATED WITH THE ARCHITECTURAL AND OTHER ALLIED ENGINEERING PLANS AS WELL AS TO COMPLETE THE STRUCTURAL WORKS IN ACCORDANCE WITH THE INTENT OF THE

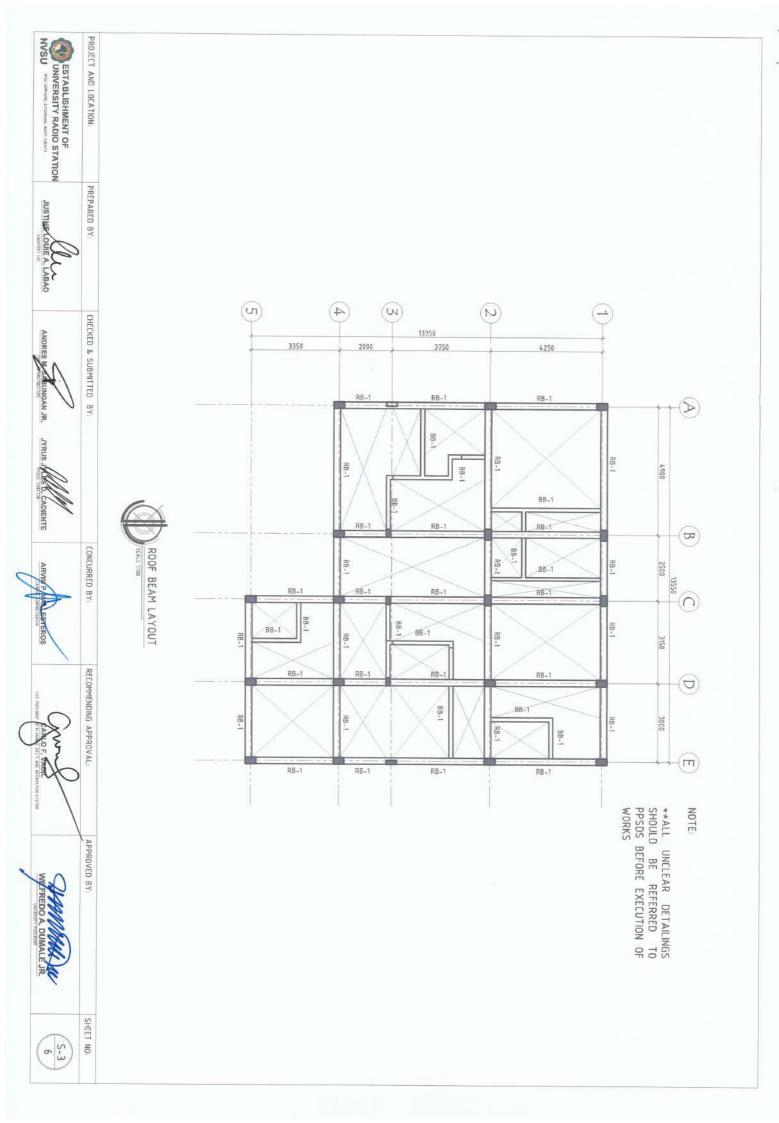
PROJECT AND LOCATION: UNIVERSITY RADIO STATION PREPARED BY: JUSTINE LOUIE A. LABAO CHECKED & SUBMITTED BY: CONCURRED BY: RECOMMENDING APPROVAL APPROVED BY: SHEET NO: 9

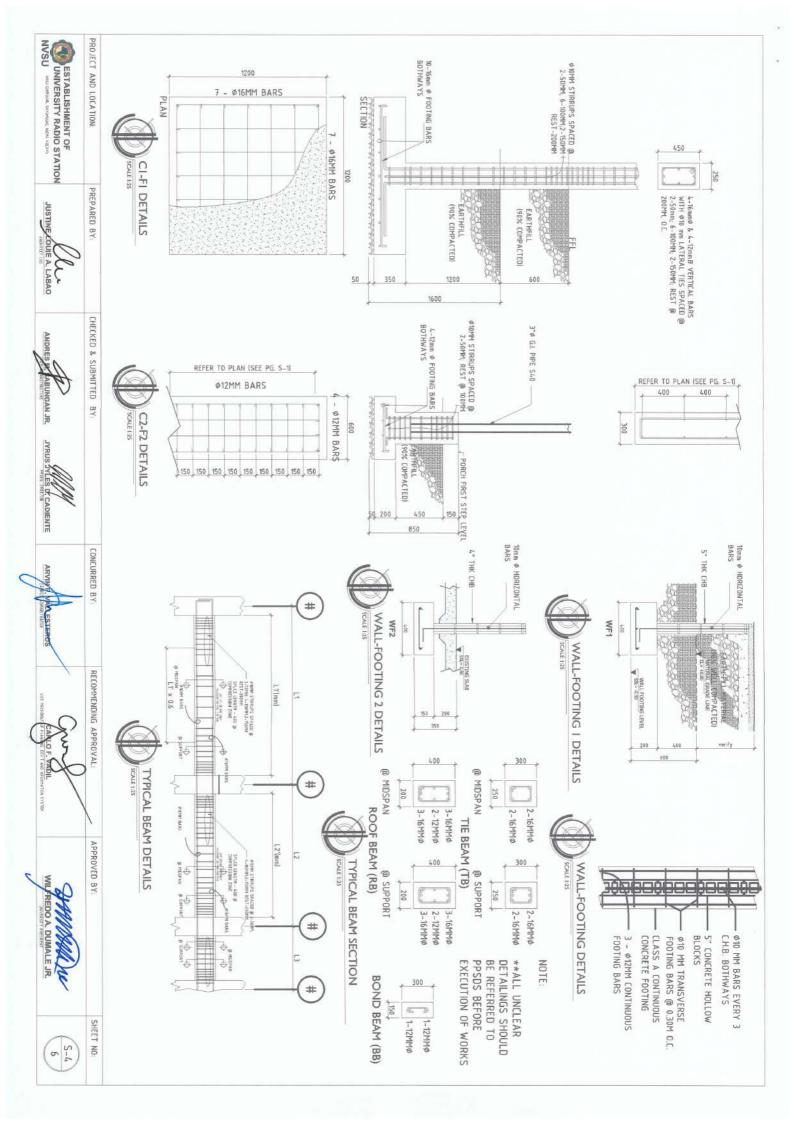


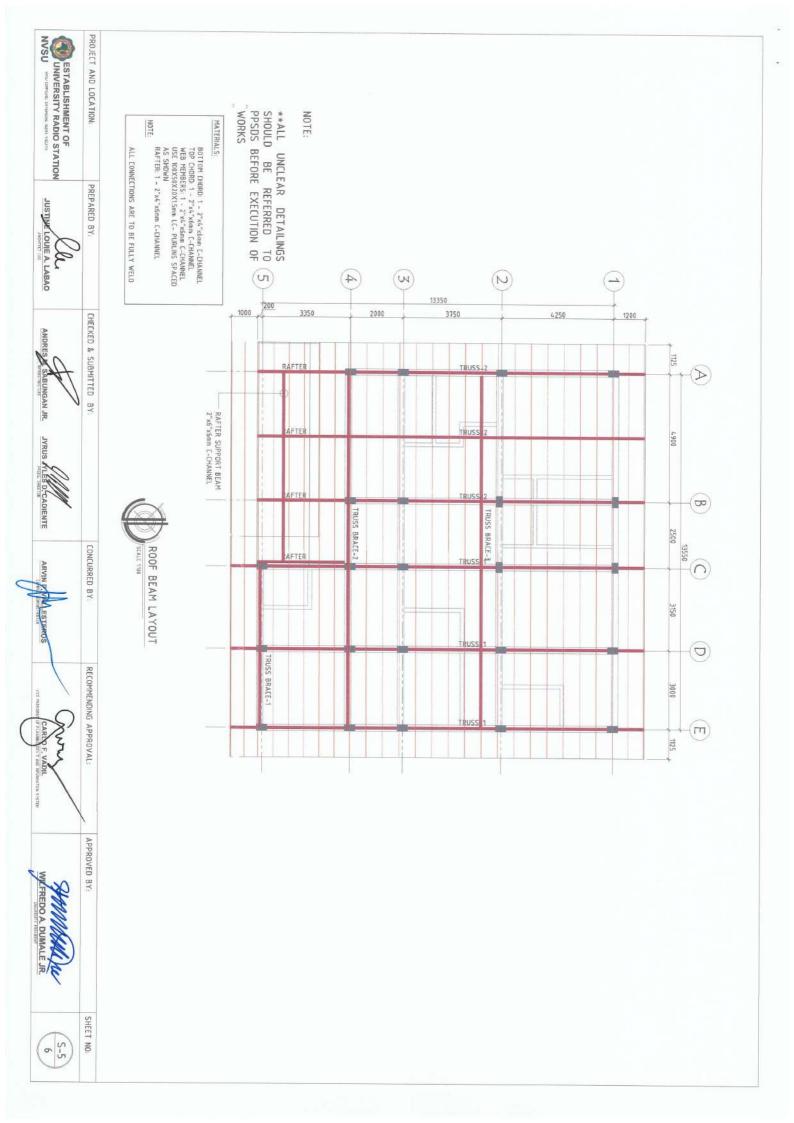


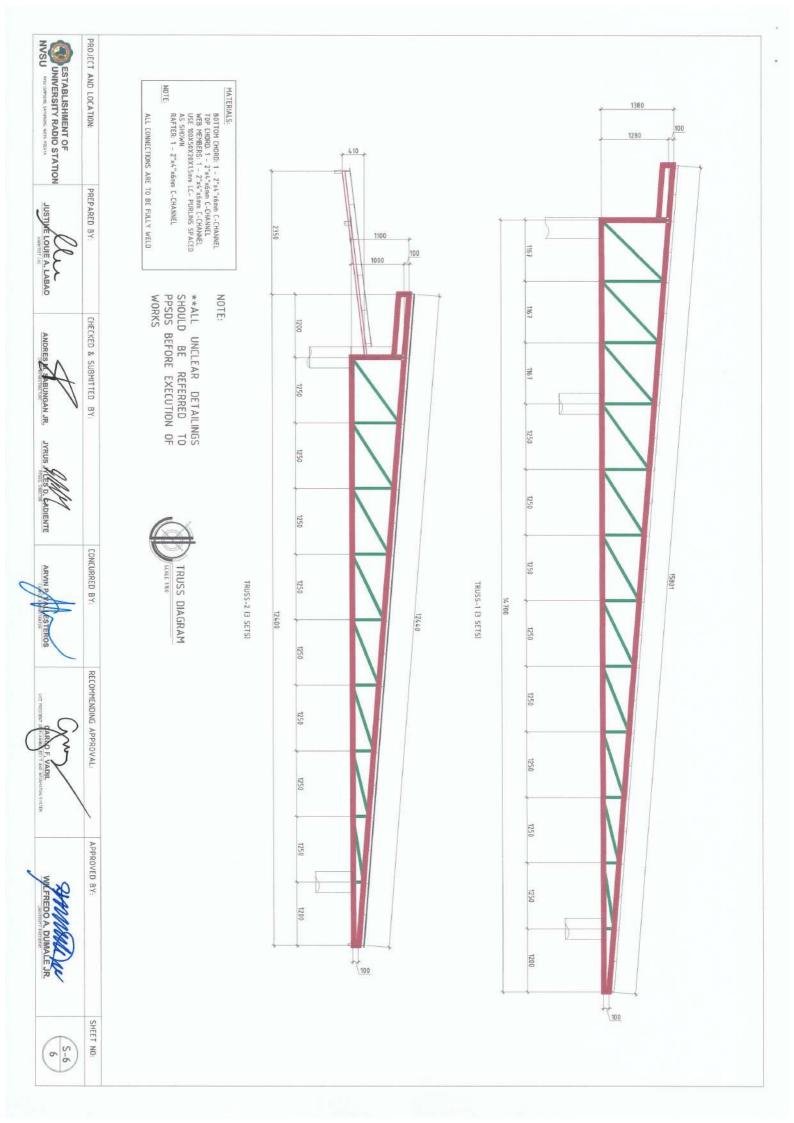


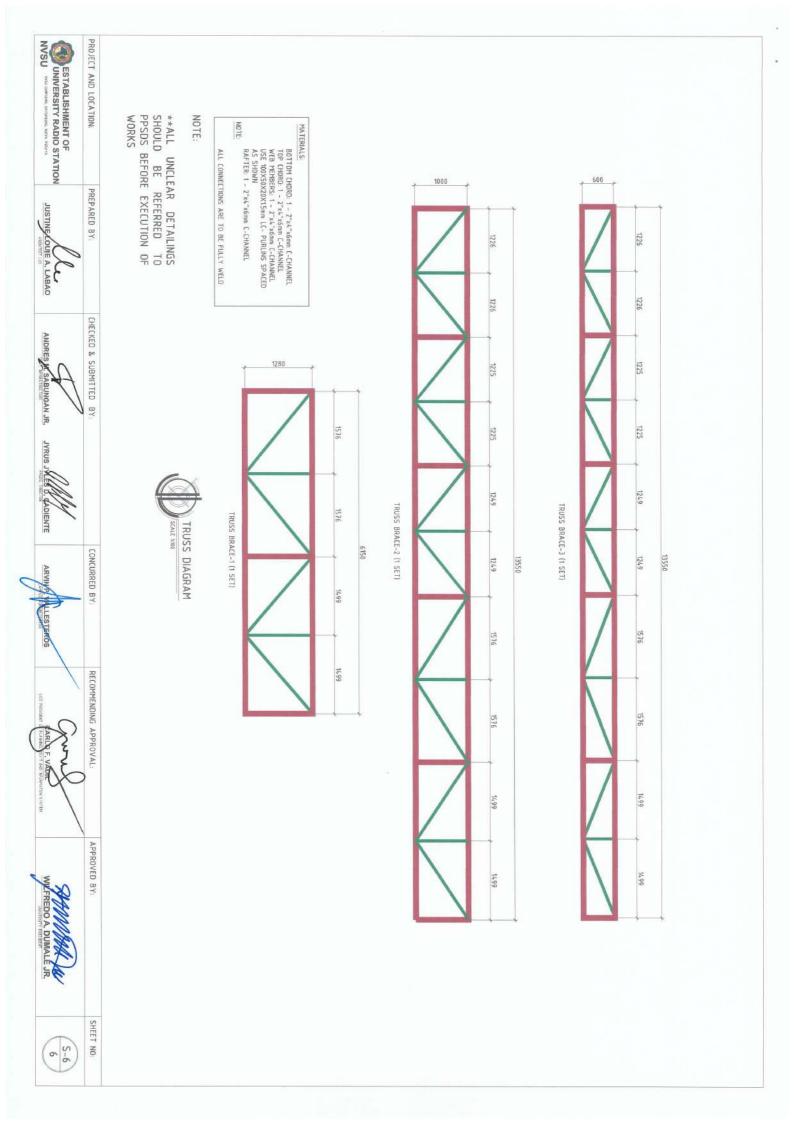


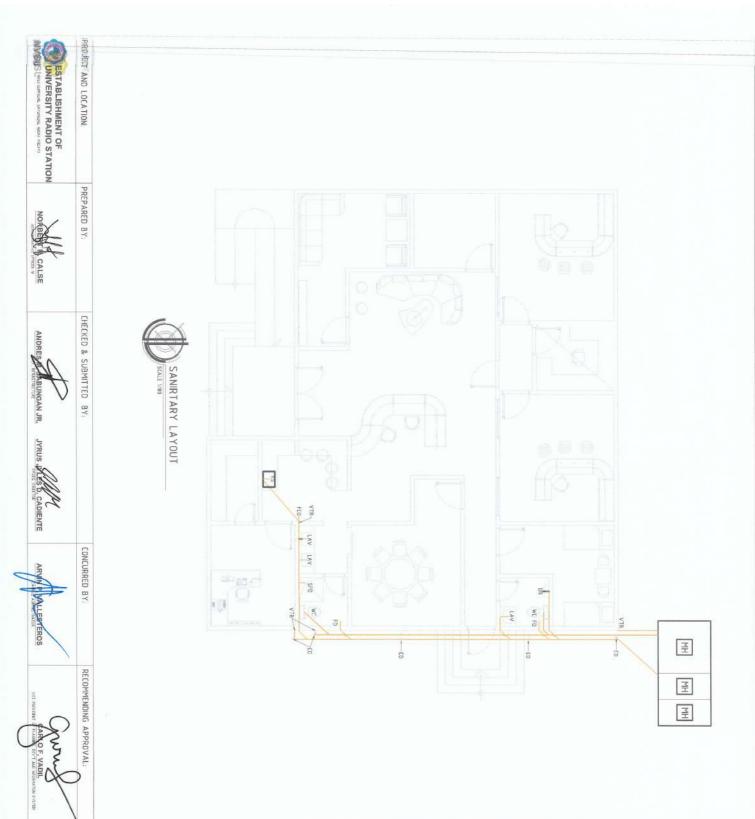












NOTE:

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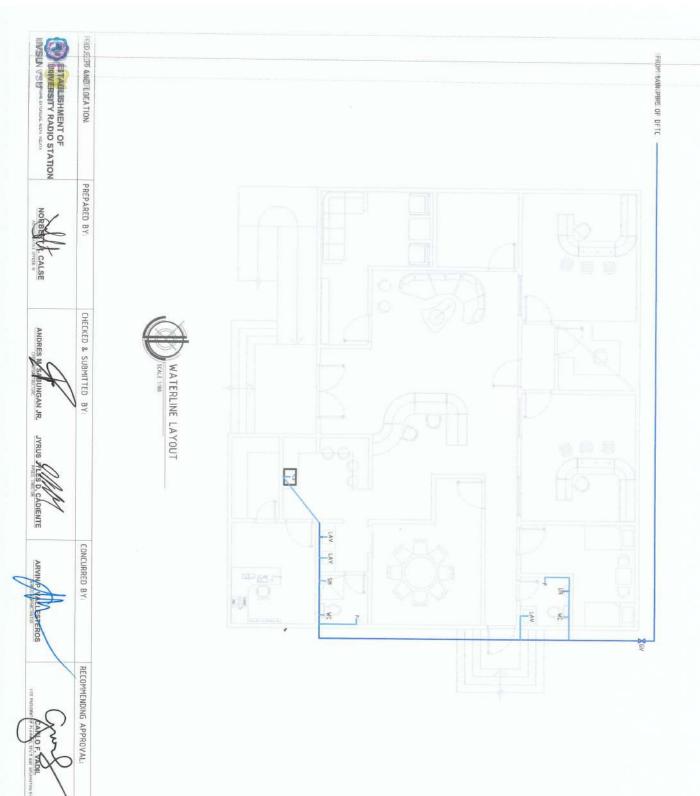
				UR	GV	KS	T	LAV	VTR	FD	WC	FCO	CO	SYMBOL	
½" Ø PPR PIPE	³™ Ø PPR PIPE	2" Ø uPVC PIPE	4" Ø uPVC PIPE	URINAL	GATE VALVE	KITCHEN SINK	FAUCET	LAVATORY	VENT THRU ROOF	FLOOR DRAIN	WATER CLOSET	FLOOR CLEAN OUT	CLEAN OUT	DESCRIPTION	LEGEND

WILFREDO A. DUMÁLE JR.

SHEET NO:

APPROVED BY:





NOTE:

**ALL UNCLEAR DETAILINGS
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PPSDS BEFORE EXECUTION OF
WORKS

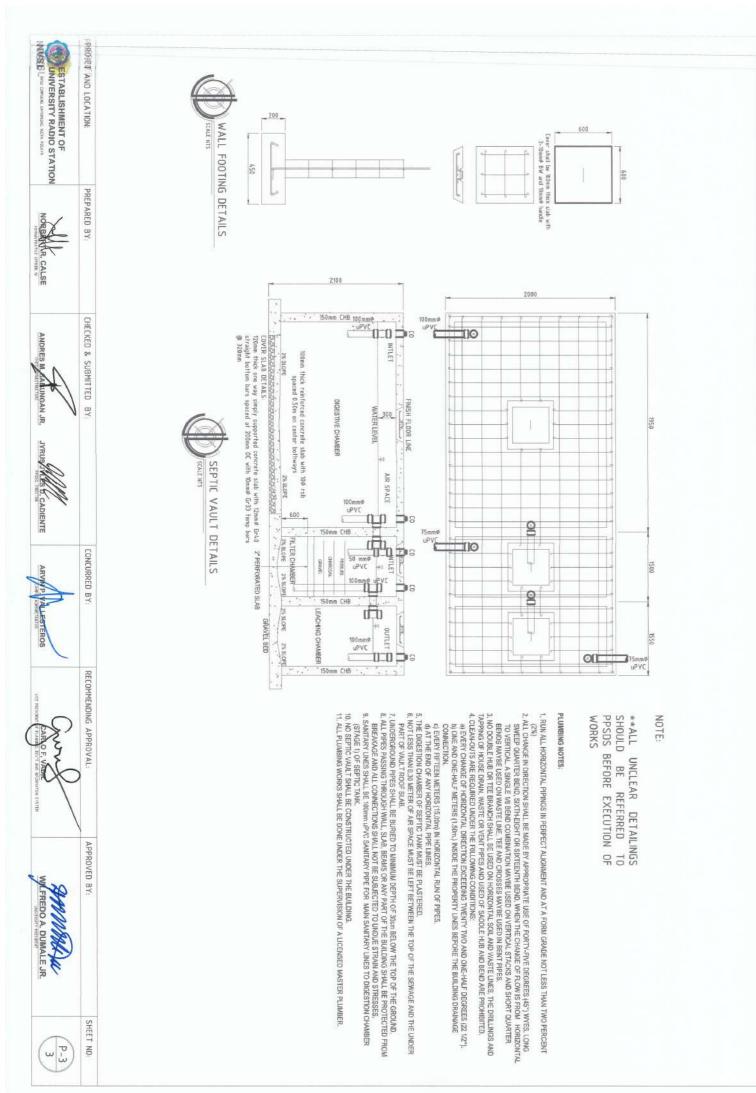
SYMBOL	DESCRIPTION
CO	CLEAN OUT
FCO	FLOOR CLEAN OUT
WC	WATER CLOSET
FD	FLOOR DRAIN
VTR	VENT THRU ROOF
LAV	LAVATORY
F	FAUCET
KS	KITCHEN SINK
GV	GATE VALVE
UR	URINAL
	4" Ø uPVC PIPE
	2" Ø uPVC PIPE
	₹ Ø PPR PIPE
	½" Ø PPR PIPE

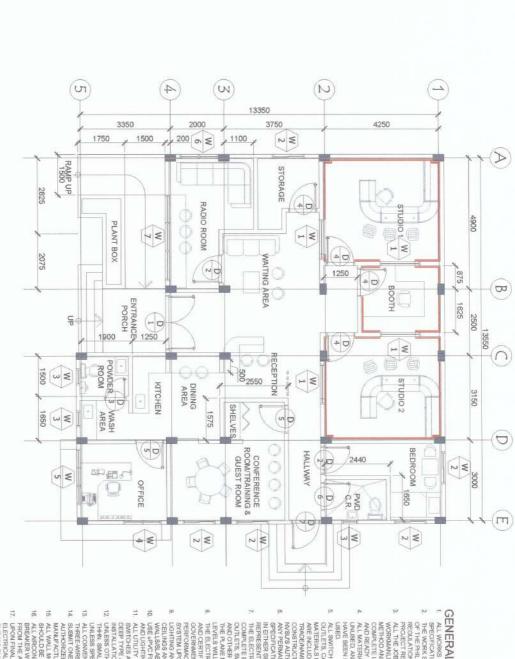
SHANNING MI WINFREDO A DUMALE JR.

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APPROVED BY:

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E | FLOOR PLAN FOR ELECTRICAL SCALE 1:100

GENERAL NOTES AND SPECIFICATIONS

ALL WORKS SHALL BE DONE IN ACCORDANCE WITH THE PLANS AND SPECIFICATIONS
THE WARK SHALL COMPLY WITH THE PROVISION OF THE LATEST EDITION OF THE PHILIPPINE ELECTRICAL COOR, LAWS, ORDINANCES, RULES AND JURISDICTION OVER THE

ALL THE JOB SHALL BE EXECUTED IN THE MOST THOROXCH PROMPT AND WORKMANUNE MANNER DAPILOTING STANDARD TOOLS EQUIPMENT, METHOD AND GOOD ENSINEESHING PRACTICES. THE JOB SHALL BE DONE COMPLETE IN ALL ASPECTS AS REQUIRED PER PLANS AND SPECIFICATIONS.

AND READY FOR OPERATIONS.
ALL MATERIALS TO BE USED SHALL BE BRAND NEW, WITH TRADE NAME,
UNUSED, AND SHALL EVERY CASE BE THE BEST WHERE SUCH STANDARDS HAVE BEEN ESTABLISHED FOR THE PARTICULAR TYPE OF MATERIALS

NVSLUS AUTHORIZED REPRESENTATIVE FOR APPROVAL
ANY PERMANENT CONFLICT BETWEEN THE ELECTROAL PLANS AND THESE
SPECIFICATIONS AND ANY UNCLEAR POINTS OF CONTROVERSIAL MATTER LISED
ALL SWITCHES, SWITCH PLATES, CONVENIENCE OUTLETS, TELEPHONE
OUTLETS, CATY OUTLETS SHALL BE BRANNED. TRADEBRAND NAME OF
MATERIALS INDICATED HEREIN ARE RECOMMENDATORY IN INATURE AND
ARE INCLUDED FOR THE PLAPOSE OF UNFORMY IN 108 DIF
TRADERNAMES OTHER THAN THOSE INDICATED ARE TO BE USED DURING CONSTRUCTION, BROCHURES AND SAMPLES SHALL BE SUBMITTED TO THE

IN EITHER SHALL BE REFERRED TO THE NYSU'S AUTHORIZED REPRESENTATIVE FOR FINAL DECISION.

THE ELECTRICAL PLANS INDICATE THE GENERAL LAYOUT OF THE COMPLETE ELECTRICAL SYSTEM, ARRANGEMENT OF FEEDERS, CIRCUIT OUTLETS, SWITCHES, CONTROLS, PANEL BOARDS, SERVICE EQUIPMENT, AND OTHER WORK FIELD VERIFICATION OF THE SCALE BIMESIONS ON THE PLANE MUSTER FIELD VERIFICATION OF THE SCALE BIMESIONS ON THE PLANE MUSTER FIELD VERIFICATION OF THE SCALE BIMESIONS AND THE PLANE MUST BE MADE. SINCE ACTUAL LOCATIONS, DISTANCES AND

ILIPELS WILL BE GOVERNED BY ACTIVAL RELD CONDITIONS

THE BLECTRICAL CONTRACTOR SHALL OBEAUNA L. NECESSARY PERMITS
AND CERTIFICATES OF ELECTRICAL NERPECTION FROM THE PROPER
AND CERTIFICATES OF ELECTRICAL NERPECTION FROM THE PROPER
AND CONTRACTOR SHALL SHALL FOR THE OPERATION OF THE
PERFORMACE OF THE WORK MADULED AND THE OPERATION OF THE
SYSTEM JPON COMPLETION OF THE WORK

UIGHTING AND POWER BRANCH CHOULT JAPK PRES CONCEALED IN
CELLINAS AND DOUBLE WALLS ANDOOR EMBECCED IN CONCRETE
WALLSSLABS

IN LIGHTING AND OTHER PIXTURES USING APPROVED FITTINGS
AND LUGHTINGS AND OTHER PIXTURES USING APPROVED FITTINGS
AND LUGHTINGS AND OTHER PIXTURES USING APPROVED FITTINGS

IN LLUTITY BOXES FOR LUGHTING OUTLETS, CONVENIENCE CUITLET,
SMITCHES AND OTHER DEVICES BALL BE MADE BY GALVANIZED IRON
DEED TYPE AND SHALL BE PAINTED WITH RED OXIDE BEFORE

UNLESS SPECIFIED SHALL BE 35m HA Copper Wire.

13. ALL CONVENIENCE CUTLETS SHALL BE BROUNDED TYPE THREE-PRONG.
THREE-WIRE, FLUSHED MOUNTED UNLESS NOIO-ATED OTHERWISE.

14. SUBMIT ONE SAMPLE OF EACH TYPE OF LIGHTING FIXTURES TO THE WISUS

AUTHORIZED REPRESENTATIVE FOR APPROVAL PROR TO

AUTHORIZED REPRESENTATIVE FOR APPROVAL PROR TO UNLESS OTHERWISE SPECIFIED, THE TYPE OF WIRES TO BE USED SHALL BE THEN SMALLEST SIZE OF WIRE TO BE USED FOR LIGHTING AND POWER

ALL WALL MOUNTED EXHAUST FAN, ORBIT FAN AND EMERGENCY LIGHT SHOULD BE PROVIDED BY A 1-GANG CONVENIENCE OUTLET JRING AND INSTALLATION

FROM THE AIRONIDTICNING EQUIPMENT

FROM THE AIRONIDTICNING FOHE WORK HEREIN DESCRIBED, THE

ELECTRICAL CONFRACTOR SHALL FUNNISH THE NOSU TWO (2) COPIES OF

THE "AS-BUILT-PLAN" FOR FUTURE REFERRENCE AND MAINTENANCE ALL ARCONDITIONING EQUIPMENT SHALL BE PROVIDED WITH A SAFETY BREAKER WITH ENCLOSURE WITHIN SIGHT OF, AND READILY ACCESSIBLE

PRC Reg No: PTR NO Place of Issue: TIN No:

Valid Until: Valid Until: Date of Issue

NS/N

NUEVA VIZCAYA STATE UNIVERSITY, BAYOMBONG CAMPUS UNIVERSITY RADIO STATION SIGNED & SEALED BY:

PROJECT TITLE & LOCATION

PREPARED BY

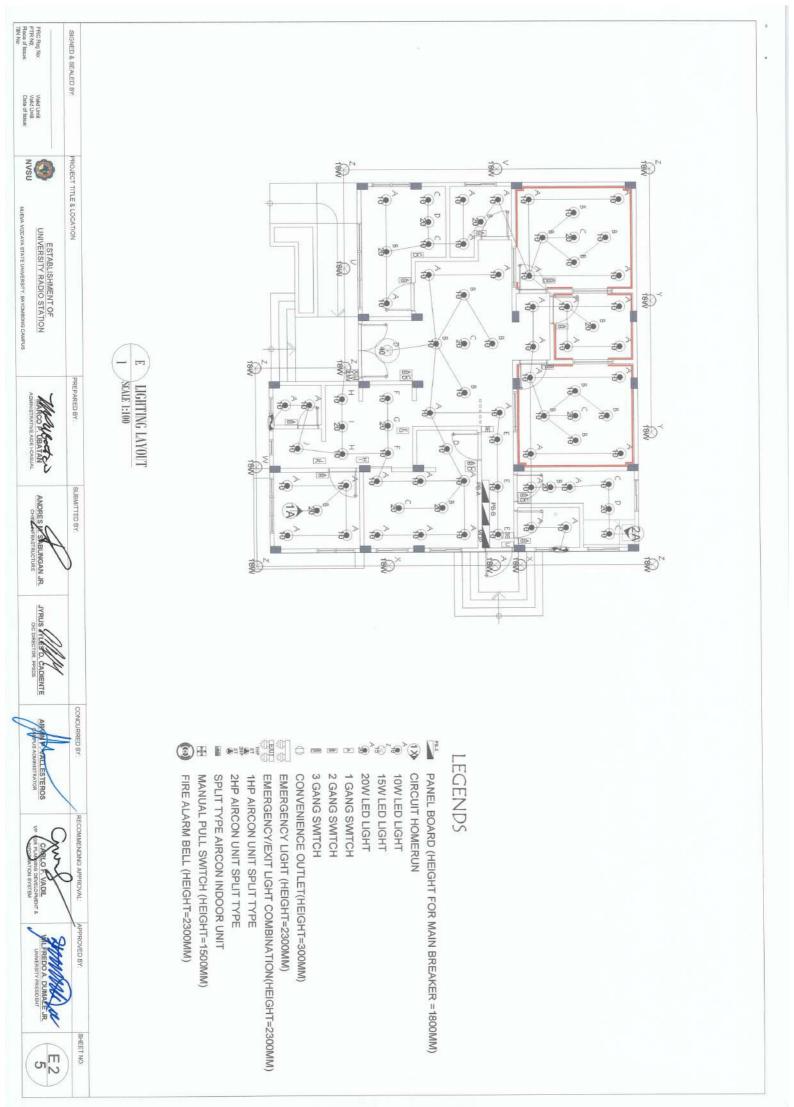
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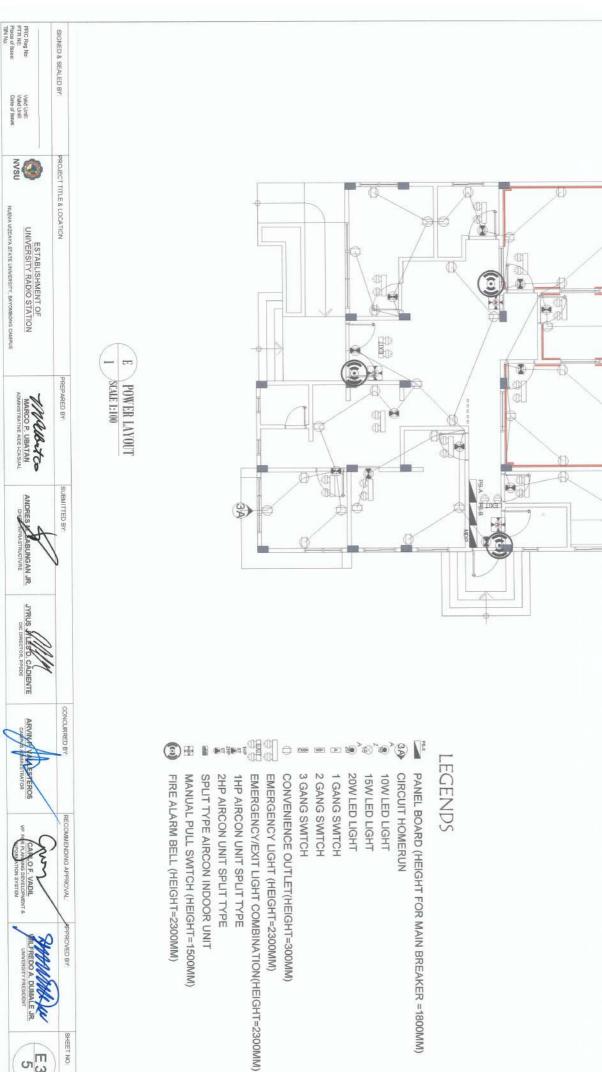
CONCURRED BY

ANDRES M. SBUNGAN JR.

25 <u>m</u>

SHEET NO.





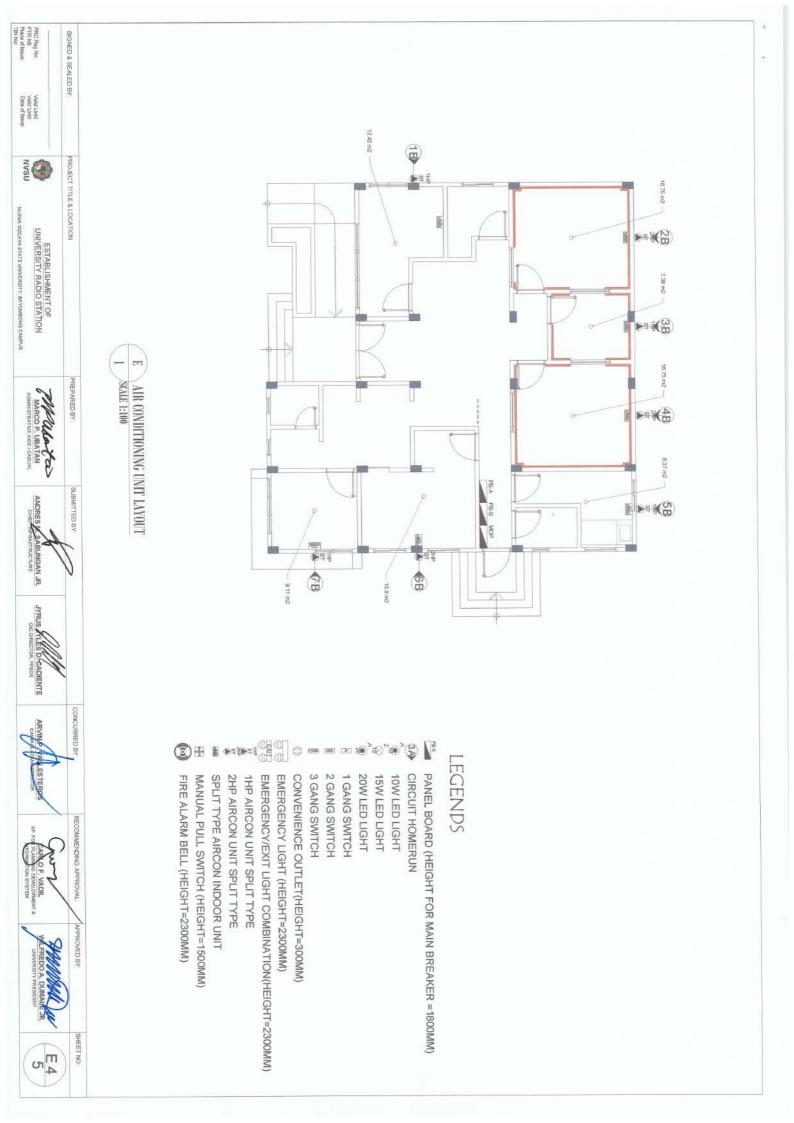
PANEL BOARD (HEIGHT FOR MAIN BREAKER =1800MM)

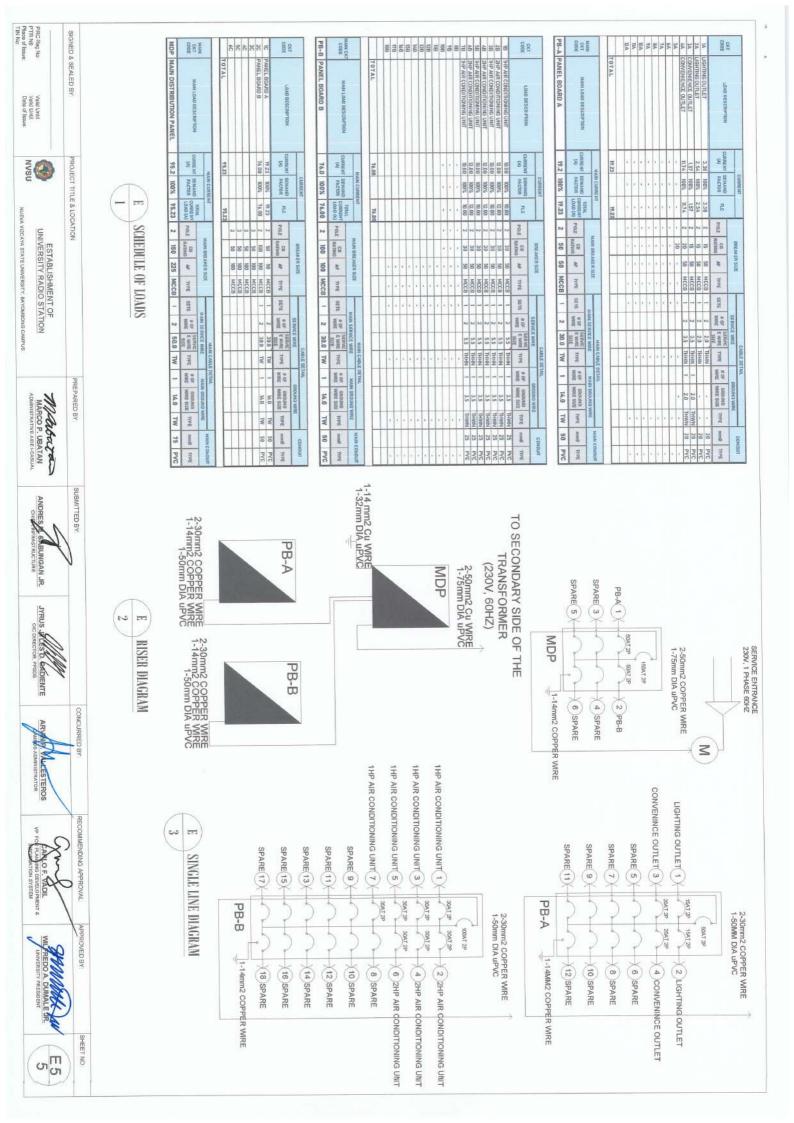
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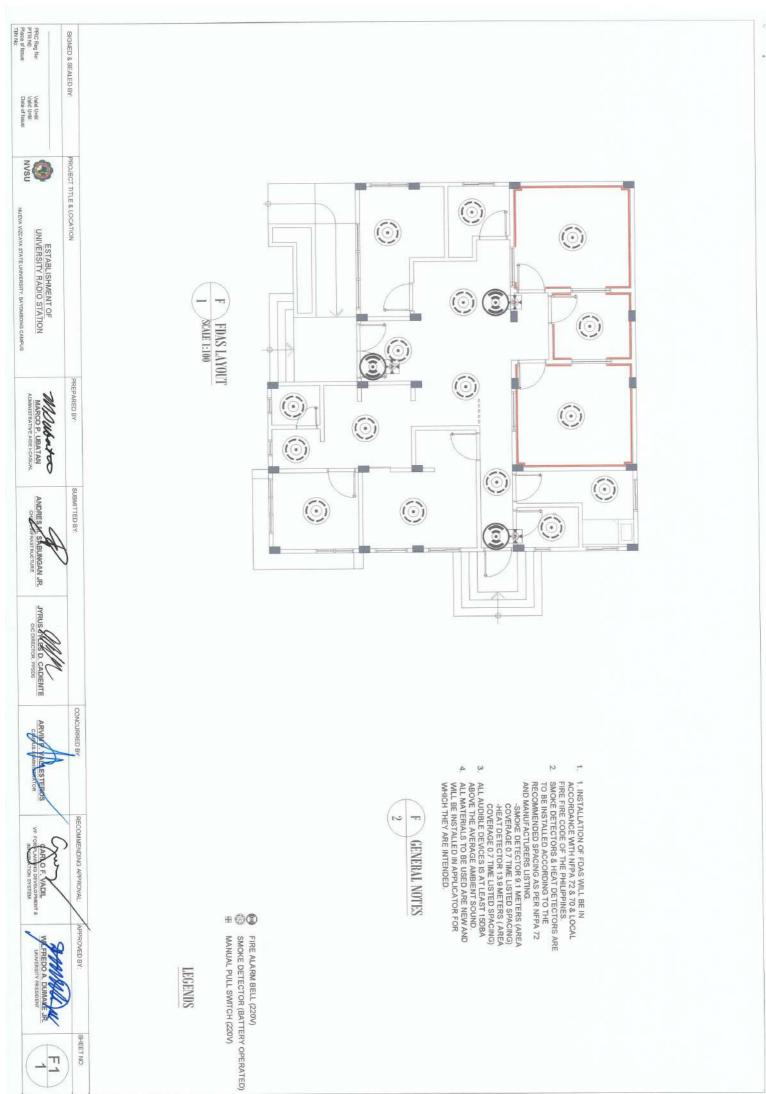


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